
SITE LAYOUT NOTES

- ALL SIGNAGE TO BE POSTED IN ACCORDANCE WITH THE UNITED STATES DEPARTMENT OF TRANSPORTATION-FEDERAL HIGHWAY ADMINISTRATION, "MANUAL ON UNIFORM TRAFFIC CONTROL DEVICES FOR STREET AND HIGHWAYS (MUTCD), LATEST EDITION.
- ALL STOP BARS SHALL BE 24" WIDE WHITE THERMO PLASTIC STRIPE. ALL OTHER STRIPING MAY BE EPOXY.
- ALL CURB AND SIDEWALKS SHALL CONFORM TO STATE AND FEDERAL BARRIER FREE DESIGN STANDARDS.
- ALL SIDEWALK RAMPS MARKED HCR TO HAVE DETECTABLE WARNING SURFACE INSTALLED IN ACCORDANCE WITH ADA REGULATIONS. ALL DETECTABLE WARNING STRIPS SHALL BE "REPLACEABLE WET-SET" OR EQUIVALENT. SURFACE MOUNT OR "STICK ON" WARNING STRIPS ARE NOT PERMITTED UNLESS NOTED OTHERWISE.
- ALL PROPOSED ON-SITE CURBING TO BE VERTICAL CONCRETE CURBING. ALL PROPOSED CURBING WITHIN MUNICIPAL OR COUNTY RIGHT-OF-WAYS TO BE VERTICAL CONCRETE CURBING.
- ALL CONNECTIONS WITH EXISTING PAVEMENTS, CURBS, SIDEWALKS, ETC SHALL BE SAW CUT.
- SIDEWALK/WALKWAY RISERS MUST BE GREATER THAN 4" AND LESS THAN 8".
- SEE LANDSCAPE PLANS FOR DETAILS ON HARDSCAPE AND PLANTING MATERIALS.
- SEE ARCHITECT'S PLANS FOR COVERED BUILDING ENTRYWAY INFORMATION.
- THIS PROJECT HAS BEEN DESIGNED IN ACCORDANCE WITH NEW JERSEY ADMINISTRATIVE CODE, TITLE 5, CHAPTER 21, "RESIDENTIAL SITE IMPROVEMENT STANDARDS".
- EXISTING CURB AND SIDEWALK ALONG THE FRONTAGE SHALL BE REPLACED IF FOUND IN POOR CONDITION.
- 12. PLANTING AREA BETWEEN THE SIDEWALK AND CURB SHALL REMAIN NATURAL GRASS.

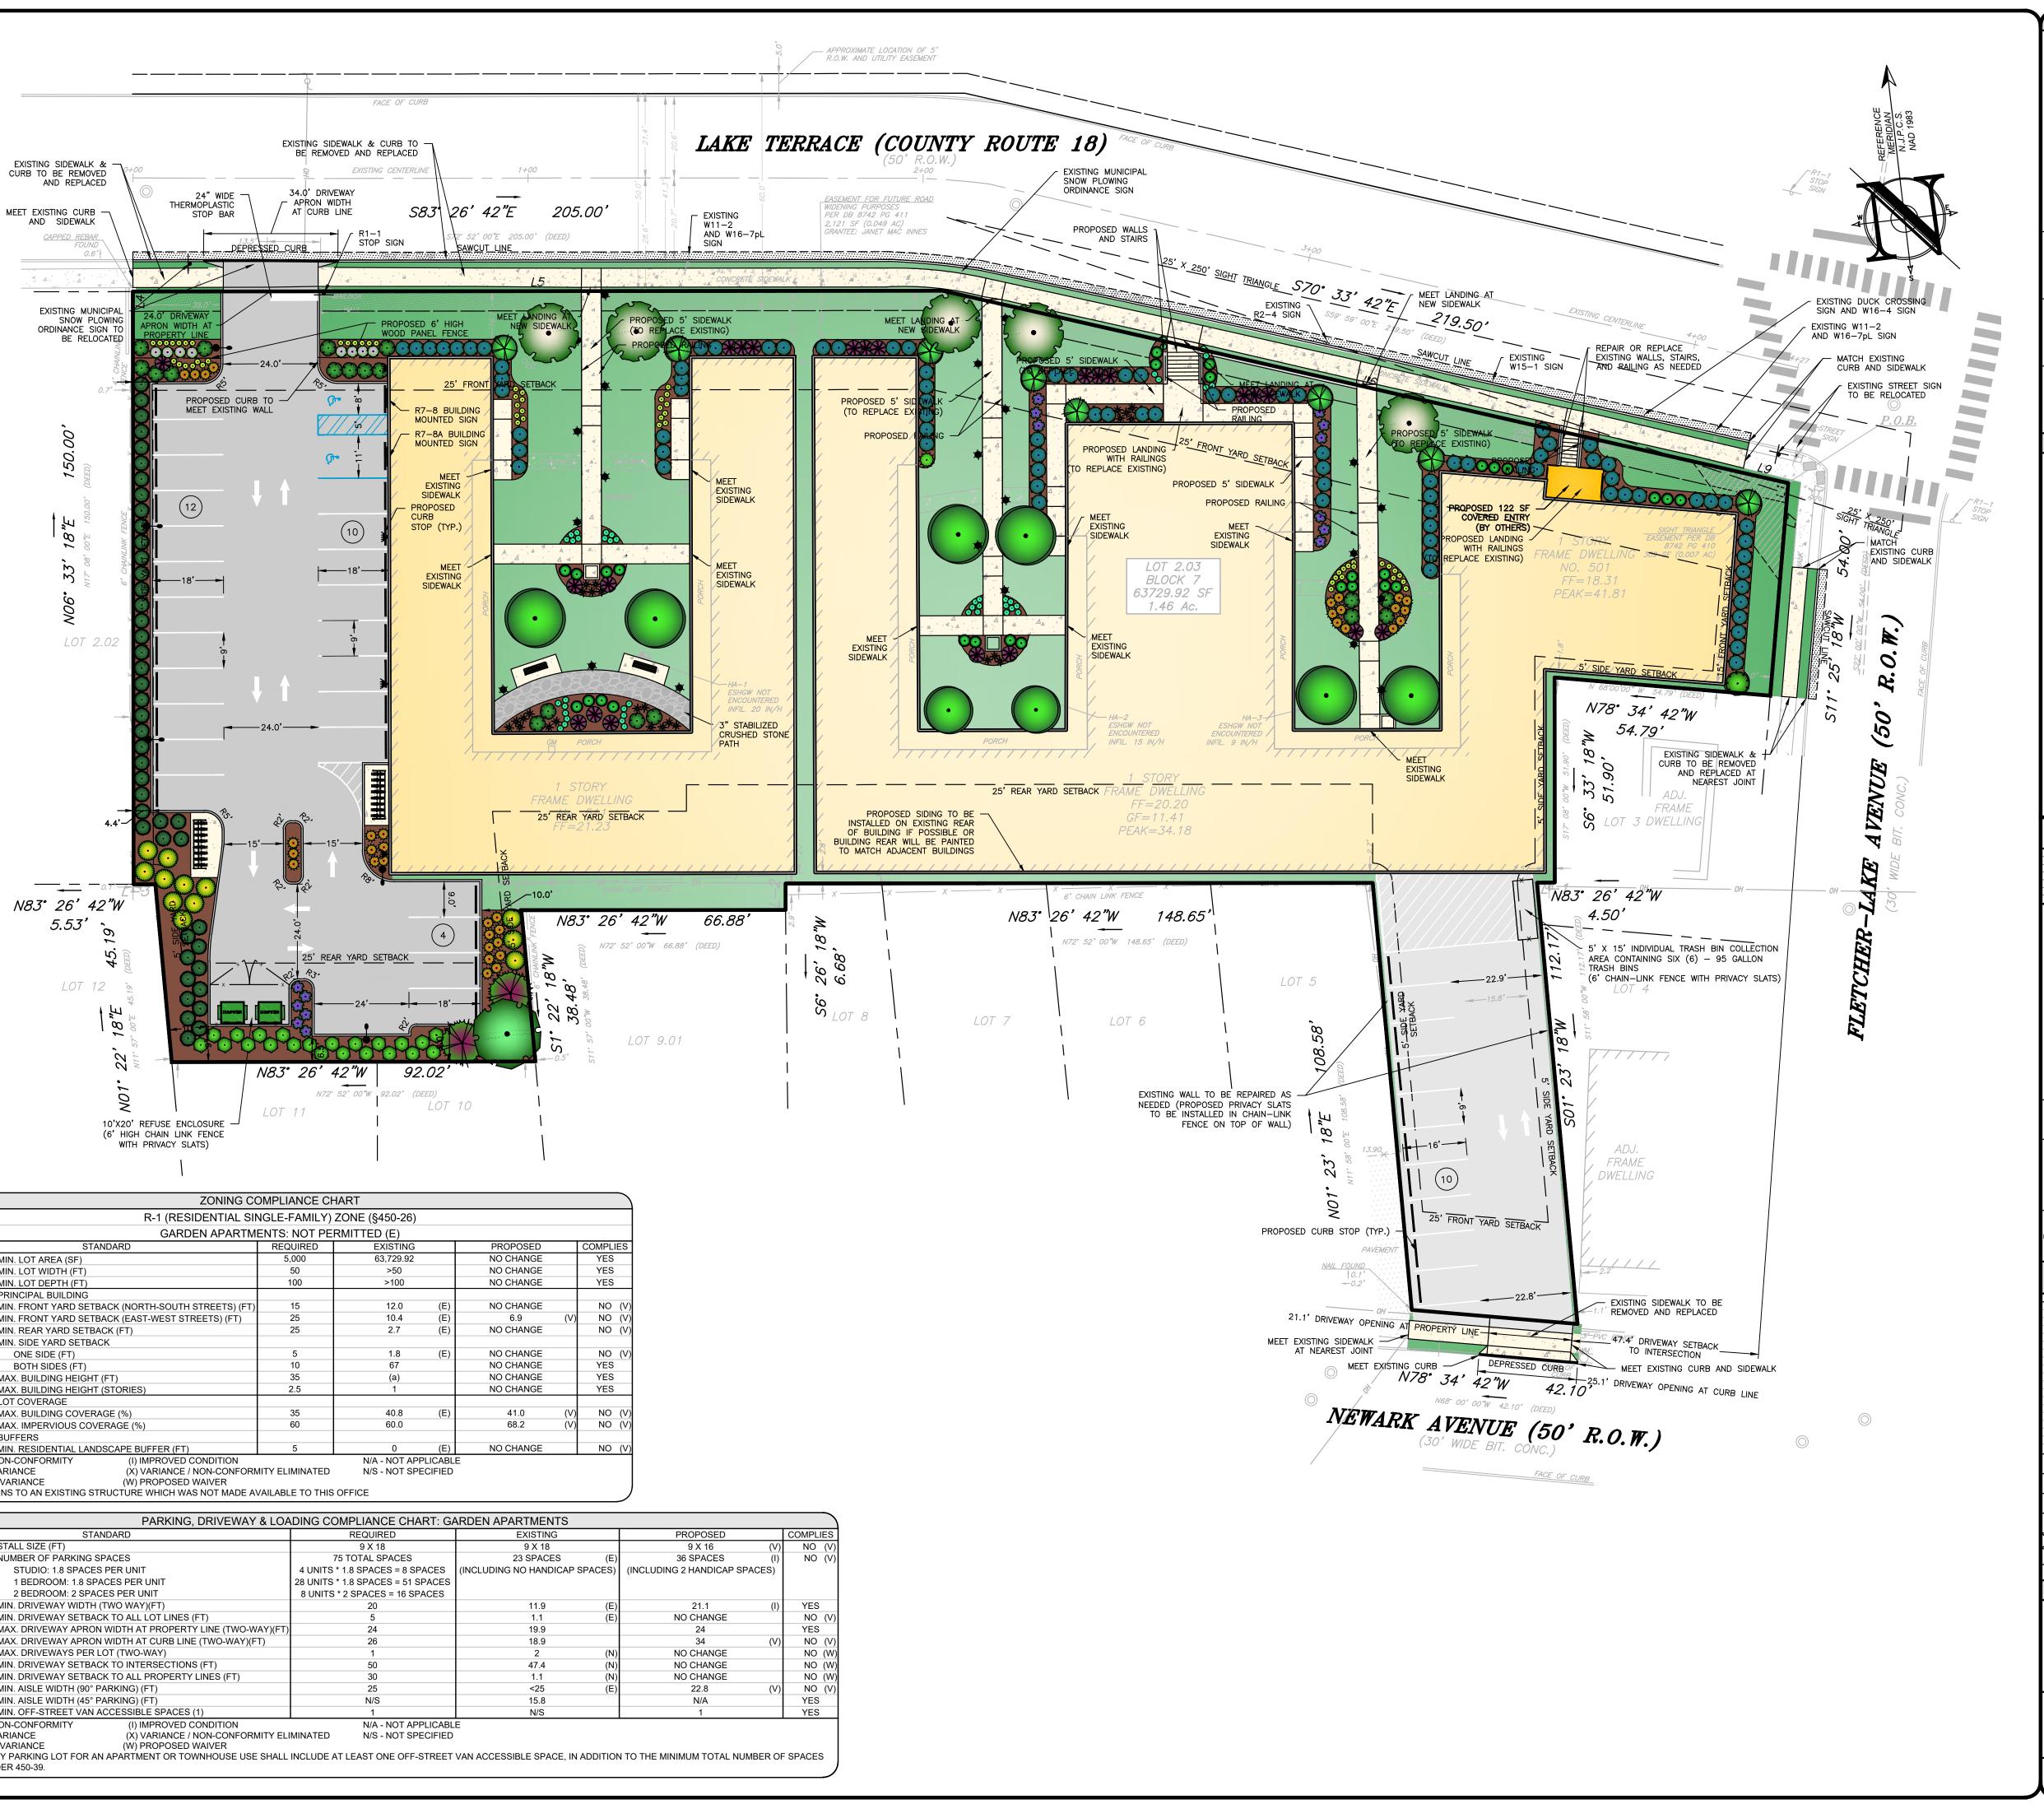

(ZONING COMPLIANCE CHART							
R-1 (RESIDENTIAL SINGLE-FAMILY) ZONE (§450-26)								
GARDEN APARTMENTS: NOT PERMITTED (E)								
ORD.SECTION	STANDARD	REQUIRED	EXISTING					
SCHEDULE	MIN. LOT AREA (SF)	5,000	63,729.92					
SCHEDULE	MIN. LOT WIDTH (FT)	50	>50					
SCHEDULE	MIN. LOT DEPTH (FT)	100	>100					
	PRINCIPAL BUILDING							
SCHEDULE MIN. FRONT YARD SETBACK (NORTH-SOUTH STREETS) (FT)		15	12.0 (E)				
SCHEDULE	MIN. FRONT YARD SETBACK (EAST-WEST STREETS) (FT)	25	10.4 (E)				
SCHEDULE	MIN. REAR YARD SETBACK (FT)	25	2.7 (E)				
SCHEDULE	MIN. SIDE YARD SETBACK							
	ONE SIDE (FT)	5	1.8 (E)				
	BOTH SIDES (FT)	10	67					
SCHEDULE			(a)					
450-26	MAX. BUILDING HEIGHT (STORIES)	2.5	1					
	LOT COVERAGE							
SCHEDULE	MAX. BUILDING COVERAGE (%)	35	40.8 (E)				
SCHEDULE	MAX. IMPERVIOUS COVERAGE (%)	60	60.0					
	BUFFERS							
450-45	MIN. RESIDENTIAL LANDSCAPE BUFFER (FT)	5	0 (E)				
(N) EXISTING NON-CONFORMITY (I) IMPROVED CONDITION N/A - NOT APPLICABLE								
(E) EXISTING VARIANCE (X) VARIANCE / NON-CONFORMITY ELIMINATED N/S - NOT SPECIFIED								
(V) PROPOSED VARIANCE (W) PROPOSED WAIVER								
(a) THIS PERTAINS TO AN EXISTING STRUCTURE WHICH WAS NOT MADE AVAILABLE TO THIS OFFICE								

ORD.SECTION		DING COMPLIANCE CHART: GA	
450-41(B)	STALL SIZE (FT)	9 X 18	
R.S.I.S.	NUMBER OF PARKING SPACES	75 TOTAL SPACES	
	STUDIO: 1.8 SPACES PER UNIT	4 UNITS * 1.8 SPACES = 8 SPACES	(INC
	1 BEDROOM: 1.8 SPACES PER UNIT	28 UNITS * 1.8 SPACES = 51 SPACES	Ì
	2 BEDROOM: 2 SPACES PER UNIT	8 UNITS * 2 SPACES = 16 SPACES	
450-41(B)	MIN. DRIVEWAY WIDTH (TWO WAY)(FT)	20	
450-41(B1)	MIN. DRIVEWAY SETBACK TO ALL LOT LINES (FT)	5	
450-41(B)	MAX. DRIVEWAY APRON WIDTH AT PROPERTY LINE (TWO-WAY)(FT)	24	
450-41(B)	MAX. DRIVEWAY APRON WIDTH AT CURB LINE (TWO-WAY)(FT)	26	
450-41(B)	MAX. DRIVEWAYS PER LOT (TWO-WAY)	1	
450-41(B)	MIN. DRIVEWAY SETBACK TO INTERSECTIONS (FT)	50	
450-41(B7)	MIN. DRIVEWAY SETBACK TO ALL PROPERTY LINES (FT)	30	
450-41(B)	MIN. AISLE WIDTH (90° PARKING) (FT)	25	
450-41(B)	MIN. AISLE WIDTH (45° PARKING) (FT)	N/S	
450-41(B)	MIN. OFF-STREET VAN ACCESSIBLE SPACES (1)	1	
(N) EXISTING I	NON-CONFORMITY (I) IMPROVED CONDITION	N/A - NOT APPLICABL	E
(E) EXISTING \	/ARIANCE (X) VARIANCE / NON-CONFORMITY ELI	MINATED N/S - NOT SPECIFIED	
	O VARIANCE (W) PROPOSED WAIVER		
	RY PARKING LOT FOR AN APARTMENT OR TOWNHOUSE USE SHALL	INCLUDE AT LEAST ONE OFF-STREET	VAN
REQUIRED UN	IDEK 450-39.		

	LEGEND	
EXISTING		PROPOSED
	BOUNDARY LINE	<u> </u>
	CONTOUR LINE	- 6
+ 46.80	SPOT ELEVATION	+46.80
Kunnin Martin	BUILDING	
	WALL	
G G	GAS	GAS
W W	WATER	WTR
	INLET	
0	STORM	D
0	SANITARY MAIN	\$
SANO	O SANITARY LATERAL	SAN
——————————————————————————————————————	OVERHEAD WIRE	O/H
E E	ELECTRIC	———— E ————
<i>T T</i>	TELEPHONE	TEL
ę	UTILITY POLE	
) U	HYDRANT	X
0	SIGN POST	
x x	FENCE	x x
<u>Å</u>	LIGHT FIXTURE	•-•
	TEST PIT LOCATION	
*		

GRADE FLOW ARROW

PROJECT NAME:							
501-511							
LAKE							
TERRACE							
PROJECT LOCATION: BLOCK 7, LOT 2.03							
501-511 LAKE TERRACE BOROUGH OF BRADLEY BEACH							
MONMOUTH COUNTY, NJ TAX MAP SHEET #1							
501 LAKE TERRACE, LLC 1412 MAIN STREET ASBURY PARK, NJ 07712 (732) 772-5656							
APPLICANT: 501 LAKE TERRACE, LLC 1412 MAIN STREET ASBURY PARK, NJ 07712 (732) 772-5656							
APPLICANT'S PROFESSIONALS							
ATTORNEY: FOX ROTHSCHILD, LLP							
49 MARKET STREET MORRISTOWN, NJ 07960							
<u>ARCHITECT:</u> <u>MICHAEL SAVARESE ASSOCIATES</u> 34 SYCAMORE AVENUE, UNIT #1E LITTLE SILVER, NJ 07739							
LANDSCAPE ARCHITECT: BML STUDIO, LLC 11 PERIWINKLE DRIVE BARNEGAT, NJ 08005							
SURVEYOR:							
INSITE SURVEYING, LLC 1955 ROUTE 34, SUITE 1A WALL, NJ 07719							
STE ENGINEERING							
SINCE 2003							
CALL BEFORE YOU DIG! NJ ONE CALL800-272-1000 (at least 3 days prior to excavation)							
ELECTRIC RED GAS/OIL YELLOW COMMUNICATION/TV ORANGE WATER BLUE SEWEP GREEN							
SEWER GREEN TEMP. SURVEY MARKINGS MAGENTA PROPOSED EXCAVATION WHITE							
\mathbf{A}							
Engineering • Surveying • Planning							
CERTIFICATE OF AUTHORIZATION: 24GA28083200 1955 ROUTE 34, SUITE 1A, WALL, NJ 07719							
732-531-7100 (Ph) 732-531-7344 (Fax) InSite@InSiteEng.net www.InSiteEng.net							
LICENSED IN: NEW JERSEY, NEW YORK, PENNSYLVANIA DELAWARE, CONNECTICUT, NORTH CAROLINA COLORADO & DISTRICT OF COLUMBIA							
COLORADO, & DISTRICT OF COLUMBIA CAUTION: IF THIS DOCUMENT DOES NOT CONTAIN THE SIGNATURE AND RAISED SEAL OF THE PROFESSIONAL. IT IS NOT AN ORIGINAL							
AND RAISED SEAL OF THE PROFESSIONAL, IT IS NOT AN ORIGINAL AND MAY HAVE BEEN ALTERED							
Jason J. Juck							
ASON L. FICHTER, PE, PP, CFM, CME NJPE 43118 NJPP 726 PAPE 61968 DEPE 3813 NYPE 802295 CTPE 23291							
NCPE 33336 DCPE 900682 COPE 36605							
REVISIONS							
3 09/15/21 REV. PER COUNTY COMMENTS							
2 06/01/21 REV. PER CLIENT COMMENTS 1 05/06/21 REV. PER COUNTY COMMENTS 0 11/20/20 INITIAL RELEASE							
SCALE: 1"=20' DESIGNED BY: CMB DATE: 11/20/20 DRAWN BY: JLS							
JOB #: 20-1472-01 СНЕСКЕД ВУ: JLF сад ID: 20-1472-01r2							
APPROVED BY:							
PLAN INFORMATION							
PRELIMINARY & FINAL							
MAJOR SITE PLAN							
SHEET TITLE:							
SITE LAYOUT							
RENDERING							

SHEET NO:

1 OF 1

PROJECT INFORMATION