
PROPOSED CONVERSION/RESTORATION AT EXISTING THREE FAMILY

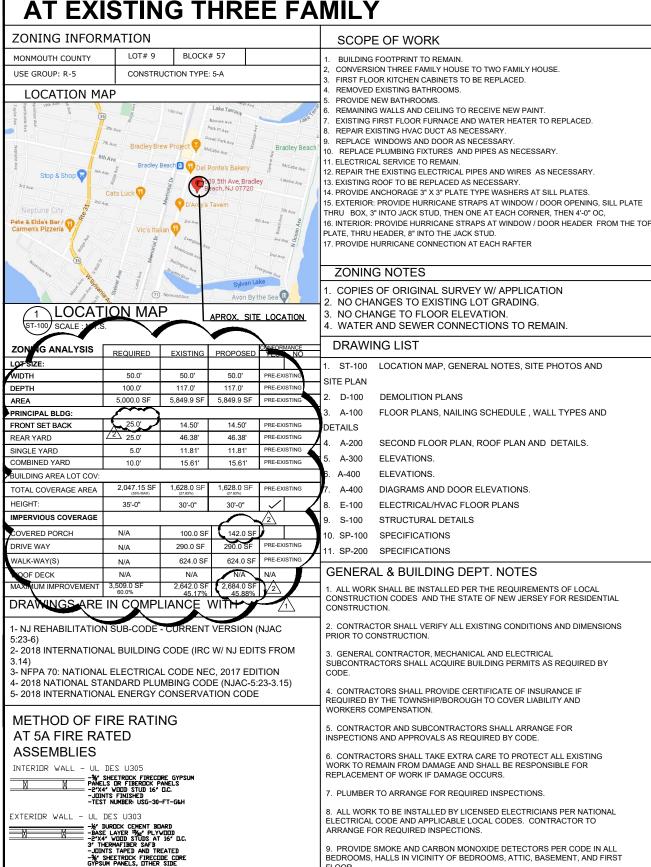

A. DOUBLE FLOOR JOISTS UNDER PARTITIONS PARALLEL TO JOIST B. PLYWOOD SHEATHING AT WALLS 1/2" PLYWOOD. AT FLOORS 3/4" OR

C. ALL HEADERS TO HAVE 4" BEARING MIN.

JOIST FLOOR/ CEILING ASSEMBLIES

-FLOOR: %'PLYWOOD WITH EXTENDING GLUE





EXISTING HAND RAILING & FRONT VIEW TO BE REPLACED.




RIGHT SIDE VIEW



LEFT SIDE VIEW



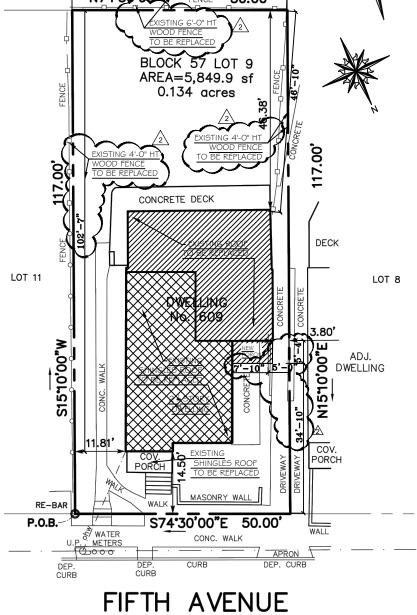

R.O.W.=50' (T.M.)

BASED ON PROPERTY DESCRIPTION MADE BY LANDMARK PROFESSIONAL SURVEYOR LANDWARK PROFESSIONAL SURVETOR RODOLFO PIERRI LICENSED LAND SURVEYOR No. 24GS03860600 DATE: 12/15/2021

EXISTING

REPLACED

RESOLUTION NUMBER

ROOF TO BE

2 SITE PLAN ST-100 SCALE : 1":10'-0"

LEGEND

EXISTING ROOF

SHINGLES TO

BE REPLACED

EXISTING	1///
FRONT PORCH	
TO REMAIN	1

PORCH

	DRAWING 7	TITLE
Z	GENERA SITE PH	ION MAP, AL NOTES, OTOS AND E PLAN
	DRAWN BY:	2.2
	CHECKED BY:	M.E
	SCALE:	AS NOTE

THA BRAZOBAN- Architect

0 North Broad Street, Suite 15 zabeth, NJ 07208 one: (908) 316-5337 c: (908) 737-7596

PROPOSED

ONVERSION/RESTORATION AT

ROJECT

WNER/CLIENT

ODETE MENDEZ

ROJECT LOCATION

BRADLEY BEACH, N.J. BLOCK: 57 LOT: 9

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	DWG NO:	SHEET NO:
	ST-100	1 OF 12


ROJECT NO: MBSS 22-00

1-31-202

APPROVED BY THE PLANNING BOARD OF THE CITY OF WEST BRADLEY BEACH AT A MEETING HELD O

THE	DAY OF	20
BOARD CHAIRPERSON		BOARD SECRETARY
CITY CLERK		CITY ENGINEER

DATE

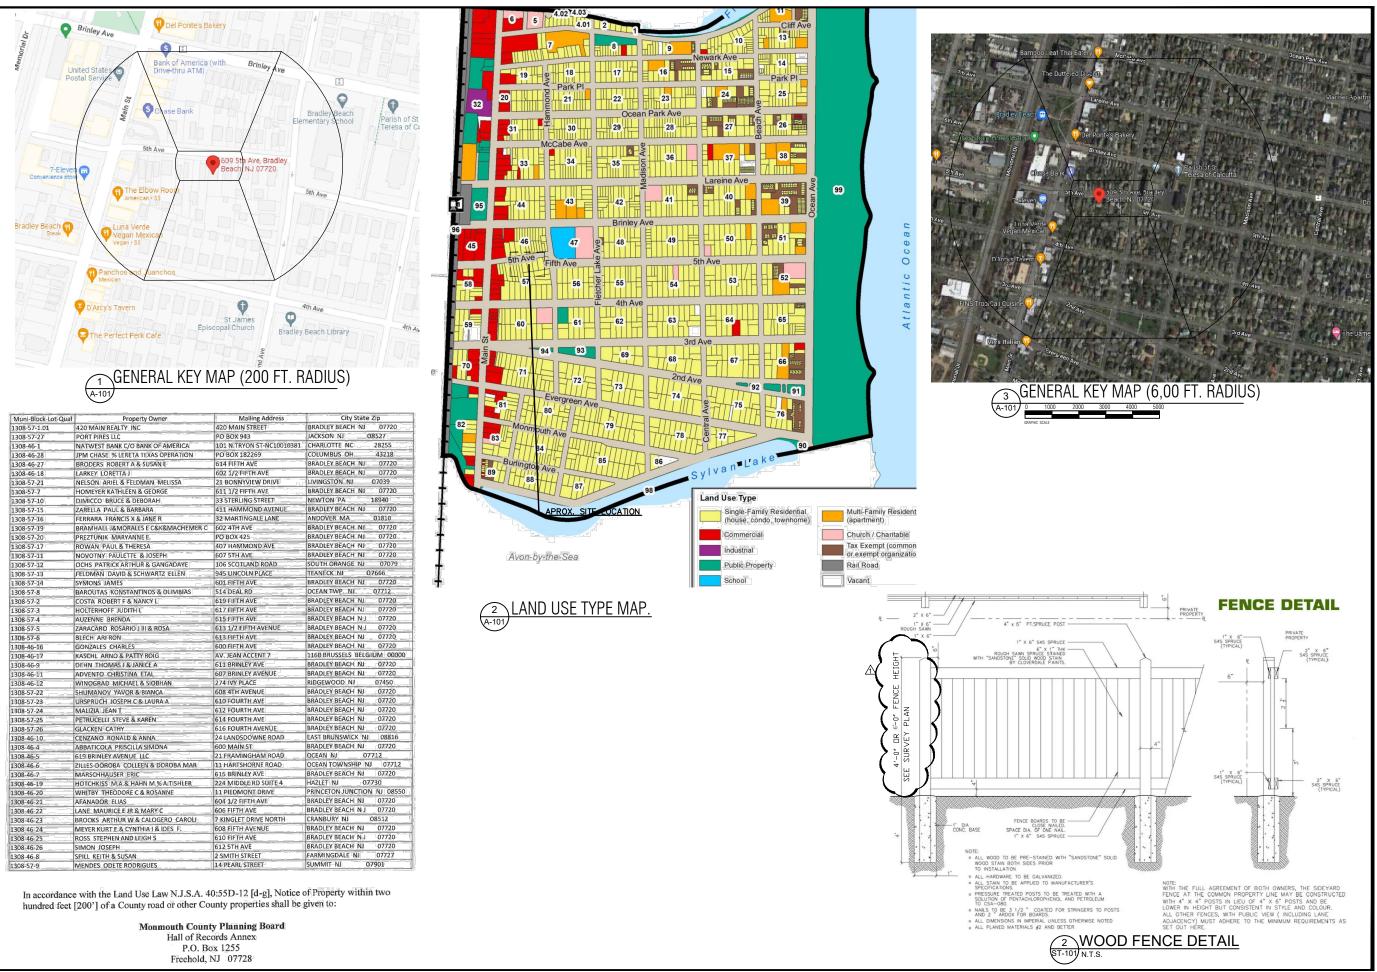

NO DATE REVISION / ISSUE

1 3-24-2022 ZONING REVISION

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Nu LICENSECETIFICATE ay4.000102002

PROJECT

PROPOSED
CONVERSION/RESTORATION AT
EXISTING THREE FAMILY HOUS

OWNER/CLIENT
ODETE MENDEZ

PROJECT LOCATION

609 FIFTH AVE
BRADLEY BEACH, N.J.
BLOCK: 57 LOT: 9


DRAWING TITLE

LOCATION MAP,
GENERAL NOTES,
SITE PHOTOS AND
SITE PLAN

DRAWN BY: S.S.
CHECKED BY: M.B.
SCALE: AS NOTED
DATE: 1-31-2022

DWG NO: SHEET NO: 2 OF 12

PROJECT NO: MBSS 22-00

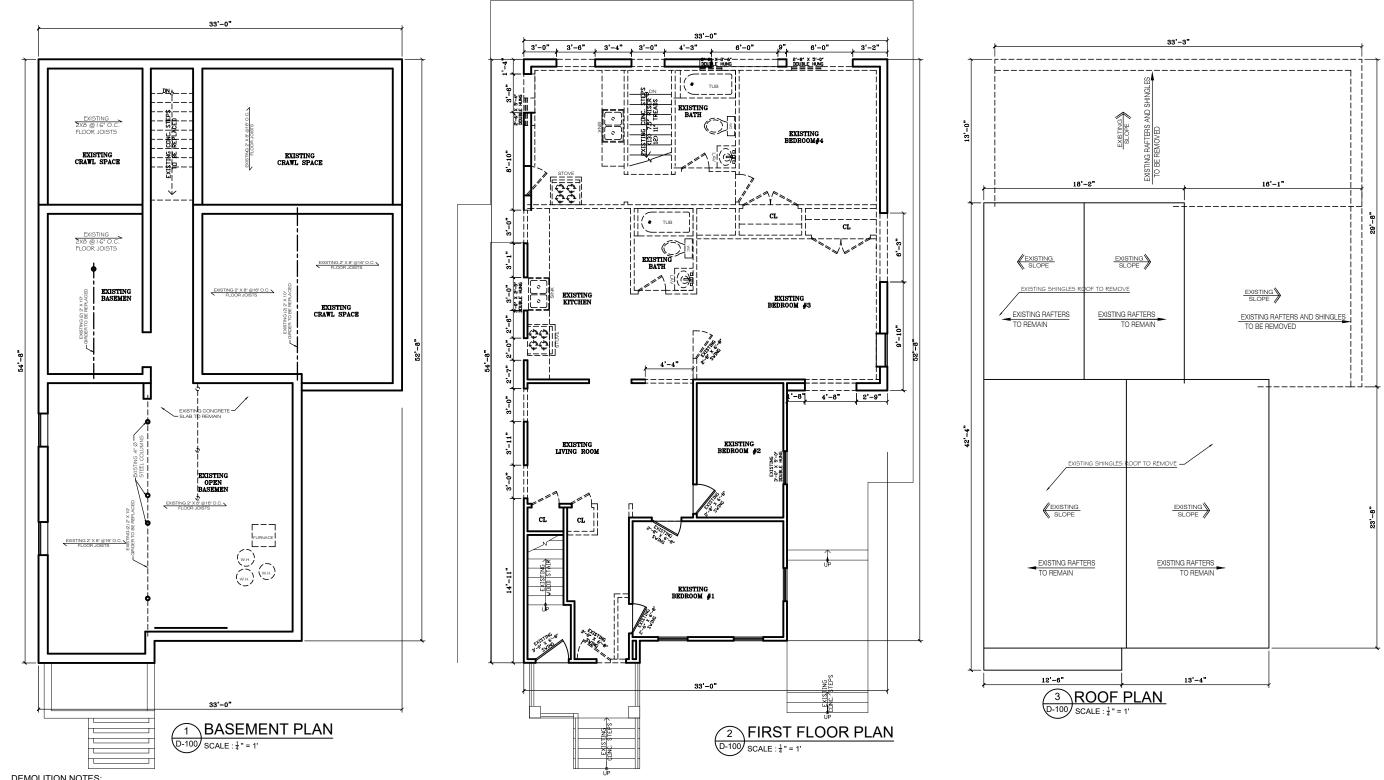

DEMOLITION NOTES:

1. ALL DEMOLISHED MATERIAL SHALL BE DISPOSED OF AT A LEGALLY APPROVED DUMP SITE AND REMOVED IN THE LEGALLY REQUIRED MANNER AS MANDATED FOR VARIOUS MATERIAL TYPES.

- PROTECTION AND PRECAUTIONS:

 1. MAINTAIN WEATHER PROTECTION FOR EXISTING STRUCTURE TO REMAIN.
- 2. ALL DEMOLISHED MATERIALS SHALL BE CONTINUOUSLY HAULED AWAY AND NOT BE ALLOWED TO ACCUMULATE.
- 3. PROVIDE ALL REQUIRED PROTECTIONS INCLUDING, BUT NOT LIMITED TO, SHORING, BRACING, AND SUPPORT TO MAINTAIN STRUCTURAL INTEGRITY
- 4. STRUCTURAL DAMAGE TO REMAINING BUILDING SHALL BE IMMEDIATELY REPORTED TO OWNER AND SHALL BE REPAIRED AT THE DEMOLITION CONTRACTOR'S EXPENSE.

- 5. SURFACES TO REMAIN SHALL BE PROTECTED FROM DAMAGE.
- 6. G.C. SHALL PROVIDE LATERAL WALL SHORING AS REQUIRED.

CUTTING AND PATCHING:
7. INSPECT EXISTING CONDITIONS, INCLUDING ELEMENTS SUBJECT TO MOVEMENT OR DAMAGE DURING CUTTING AND PATCHING.

- 8. AFTER UNCOVERING THE WORK, INSPECT CONDITIONS AFFECTING THE INSTALLATION OF NEW WORK.
- 9. IF UNCOVERED CONDITIONS ARE NOT AS ANTICIPATED, IMMEDIATELY NOTIFY THE ARCHITECT AND SECURE NEEDED DIRECTIONS.
- 10. DO NOT PROCEED IN AREAS OF DISCREPANCY UNTIL ALL SUCH DISCREPANCIES HAVE BEEN FULLY RESOLVED.

- 11. PERFORM CUTTING AND DEMOLITION BY METHODS WHICH WILL PREVENT DAMAGE TO OTHER PORTIONS OF THE WORK AND WILL PROVIDE PROPER SURFACES TO RECEIVE INSTALLATION OF REPAIR AND NEW WORK. PERFORM FITTING AND ADJUSTMENT OF PRODUCTS TO PROVIDE FINISHED INSTALLATION COMPLYING WITH THE SPECIFIED TOLERANCES AND
- 12. ALL EXISTING ELECTRICAL FIXTURES, WIRING AND OUTLETS TO REMAIN UNLESS OTHERWISE NOTED.
- 13. ALL EXISTING PLUMBING FIXTURES, PLUMBING LINES, AIR VENTS TO REMAIN UNLESS OTHERWISE NOTED.
- 14. PROVIDE NEW ELECTRICAL SUB-PANEL IN SECOND FLOOR AS SHOWN ON PLANS. EXISTING ELECTRICAL PANEL TO REMAIN.
- 15. ALL EXISTING WINDOWS AND DOORS TO BE REMOVED UNLESS OTHERWISE NOTED.


LEGE	VD
	EXISTING FOUNDATION WALL TO REMAIN
	EXISTING WALLS TO BE REMOVED.
	EXISTING WINDOW TO REMAIN
[正三三王]	EXISTING WINDOW TO BE REMOVED
7	RAILING
	EXISTING WALL TO REMAIN




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M.B. Architectural Design and Consulting, LLC		
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PROJECT		
PROPOSED CONVERSION/RESTORATION AT EXISTING THREE FAMILY HOUSE		
OWNER/CLIENT		
ODETE MENDEZ		
PROJECT LOCATION		
609 FIFTH AVE		

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DEMOLITI	ON PLANS
DRAWN BY:	2.2.
CHECKED BY:	M.B.
SCALE:	AS NOTED
DATE:	1-31-2022
DATE.	I DI LOLL
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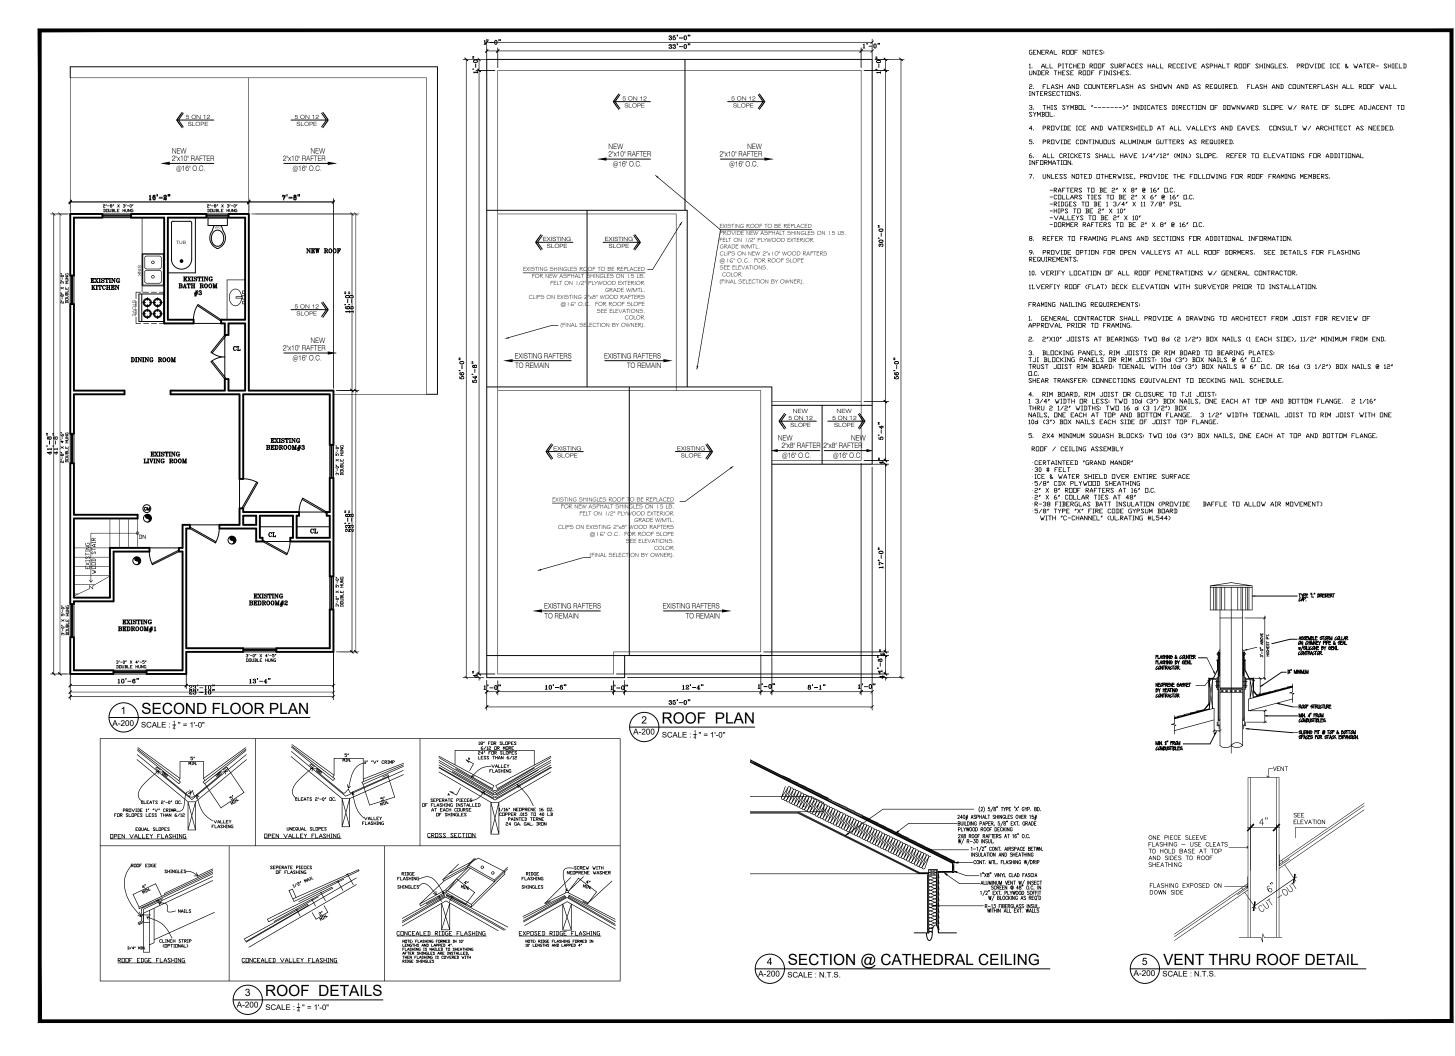


PROPOSED CONVERSION/RESTORATION AT EXISTING THREE FAMILY HOUSE
OWNER/CLIENT
ODETE MENDEZ
PROJECT LOCATION
609 FIFTH AVE BRADLEY BEACH, N.J. BLOCK: 57 LOT: 9

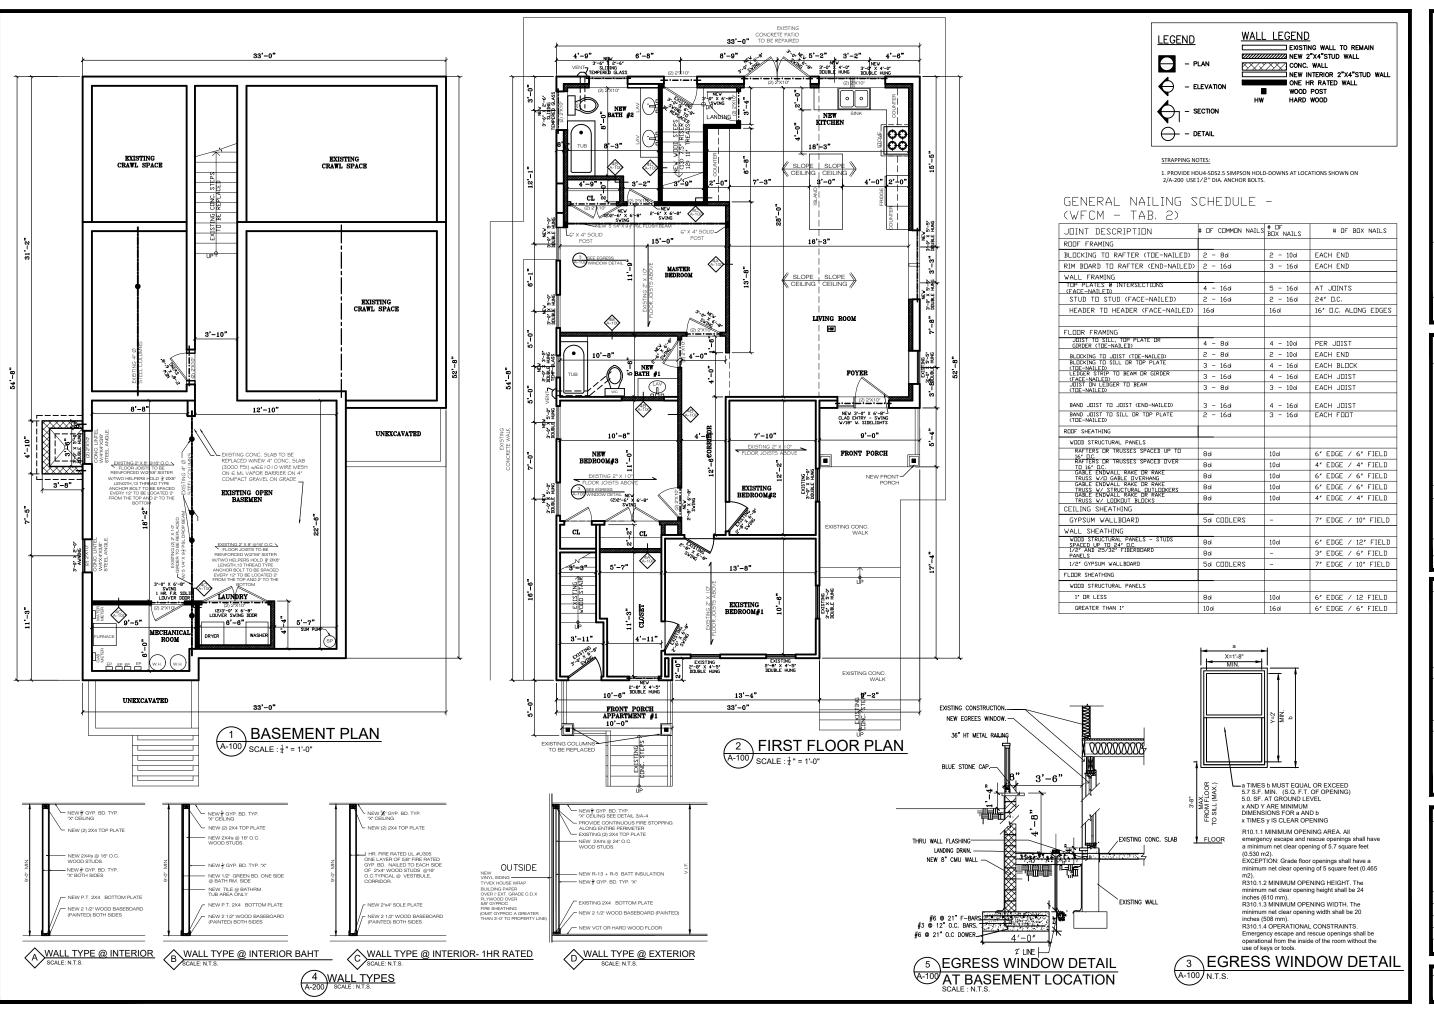PROJECT

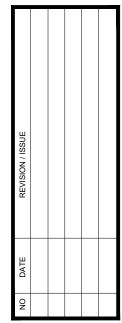DRAWING TITLE		
SCHEDULE, W	NS, NAILING ALLTYPES AND FAILS	
DRAWN BY:	2.2.	
CHECKED BY:	M.B.	
SCALE:	AS NOTED	
DATE:	1-31-2022	
PROJECT NO: M	BSS 22-002	

DWG NO:	SHEET NO:
A-100	4 OF 12





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OWNER/CLIENT

ODETE MENDEZ

PROJECT LOCATION

609 FIFTH AVE
BRADLEY BEACH, N.J.
BLOCK: 57 LOT: 9

DRAWING TITLE


SECOND FLOOR PLAN, ROOF PLAN AND DETAILS

DRAWIN BY: S.S.
CHECKED BY: M.B.
SCALE: AS NOTED


DWG NO: SHEET NO: A-200 5 OF 12

PROJECT NO: MBSS 22-00

1-31-202

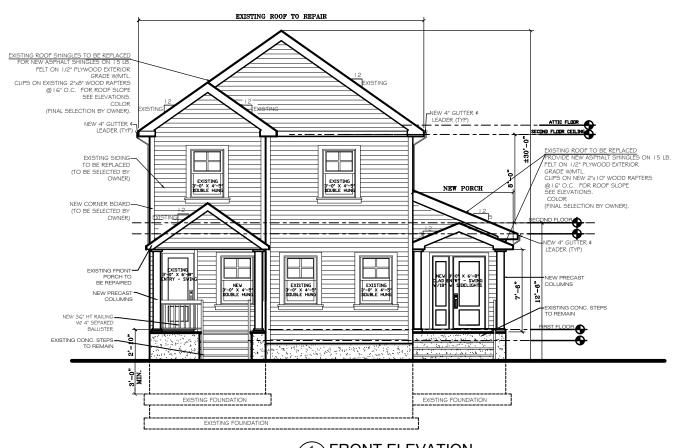

T FRONT ELEVATION
SCALE: \(\frac{1}{4}\)" = 1'

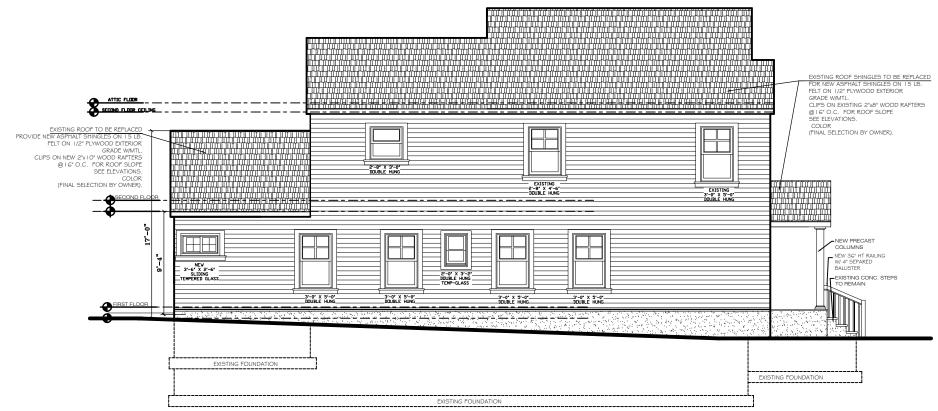

RIGHT SIDE ELEVATION

SCALE: \(\frac{1}{4}\) = 1'

REVISION / ISSUE			
DATE			
ON			



OWNER/CLIENT
ODETE MENDEZ
PROJECT LOCATION
609 FIFTH AVE BRADLEY BEACH, N.J. BLOCK: 57 LOT: 9


PROPOSED
CONVERSION/RESTORATION AT EXISTING THREE FAMILY HOUSE




ELEVATIONS

DRAWING TITLE

DWG NO:	SHEET NO:
A-300	5 OF 12

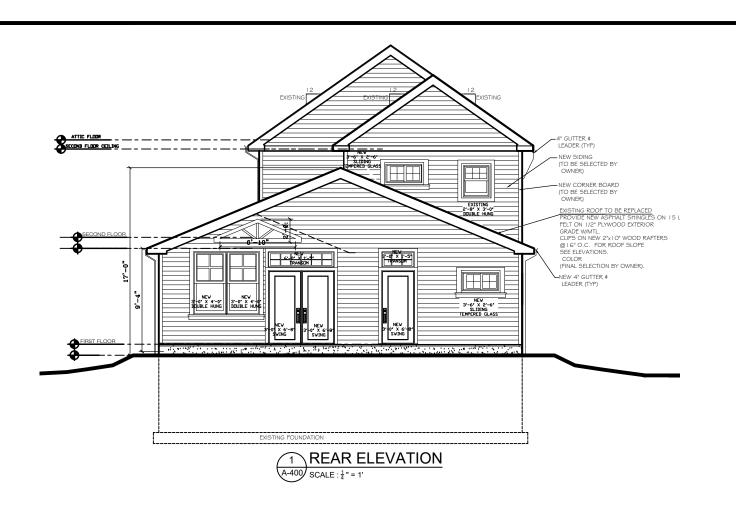

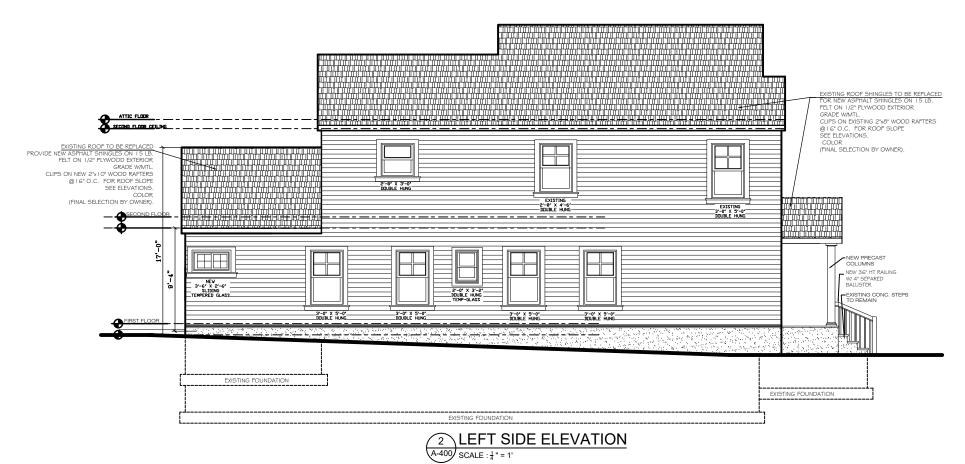





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PROPOSED CONVERSION/RESTORATION AT EXISTING THREE FAMILY HOUSE

PROJECT

OWNER/CLIENT

ODETE MENDEZ

PROJECT LOCATION


609 FIFTH AVE
BRADLEY BEACH, N.J.
BLOCK: 57 LOT: 9


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ELEVATIONS

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CHECKED BY:		M.B.
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DATE:	1-31	-2022
PROJECT NO: M	388 2	22-00

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	A-400	7 OF 12




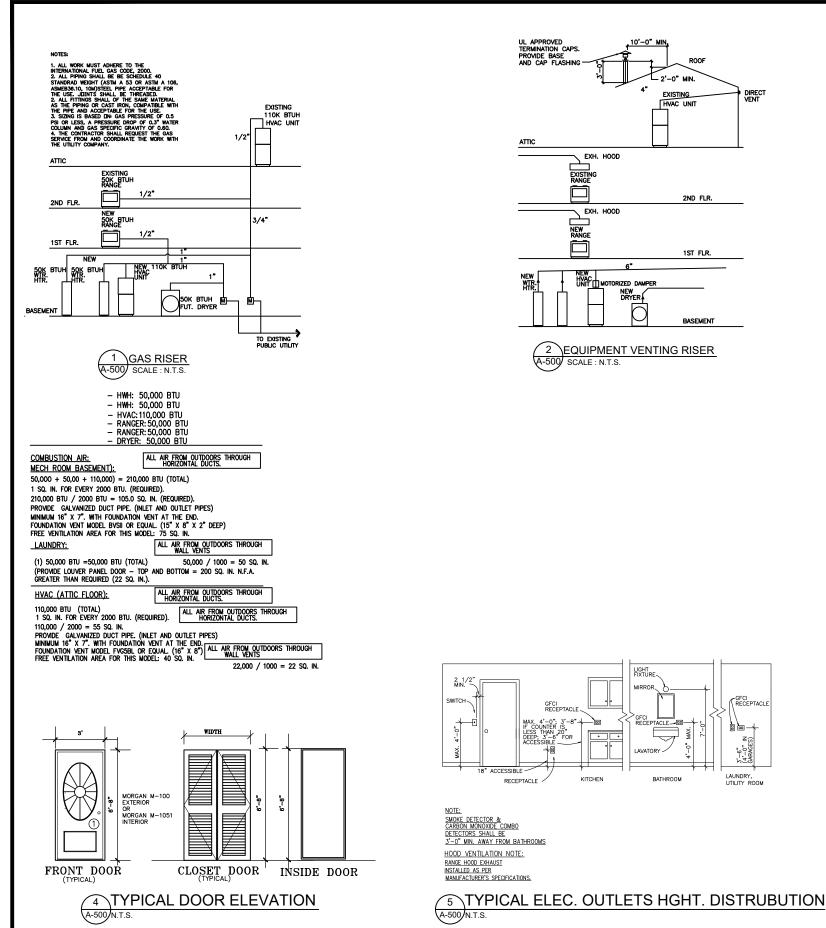


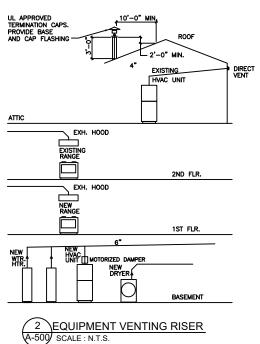
LAVATORY ~

BATHROOM

LAUNDRY, UTILITY ROOM

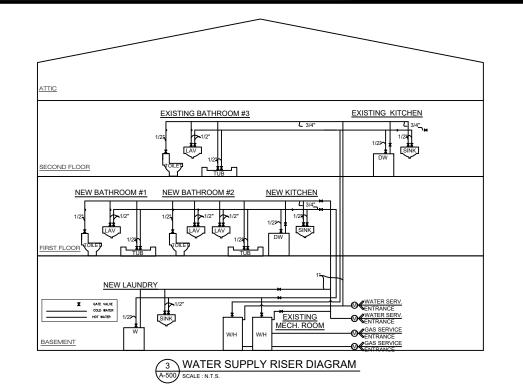

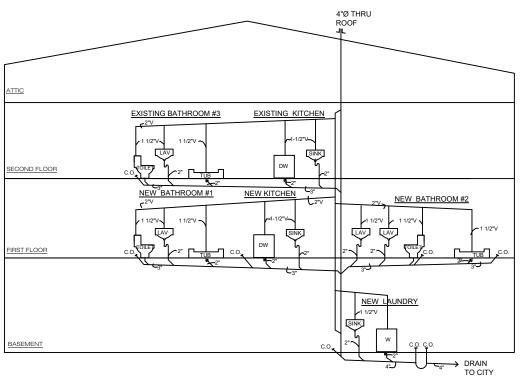

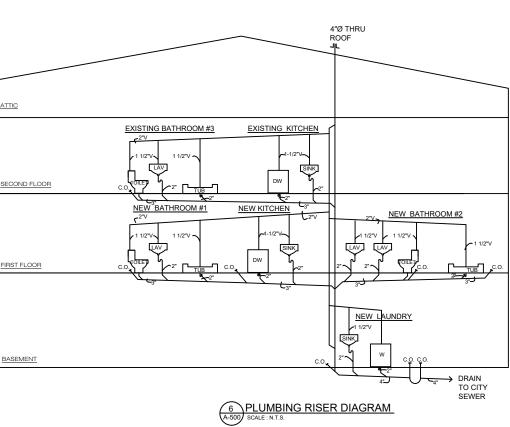

DRAWING T	ITLE
DIAGRAI DOOR EI	MS AND LEVATIONS
DRAWN BY:	2.2.
CHECKED BY:	M.B.
SCALE:	AS NOTED

VARTHA BRAZOBAN- Architect A

PROPOSED

CONVERSION/RESTORATION AT EXISTING THREE FAMILY HOUSE

PROJECT

OWNER/CLIENT


ODETE MENDEZ

PROJECT LOCATION

BRADLEY BEACH, N.J. BLOCK: 57 LOT: 9

DWG NO:	SHEET NO:
A-500	8 OF 12

1-31-202 PROJECT NO:MRSS 22-002

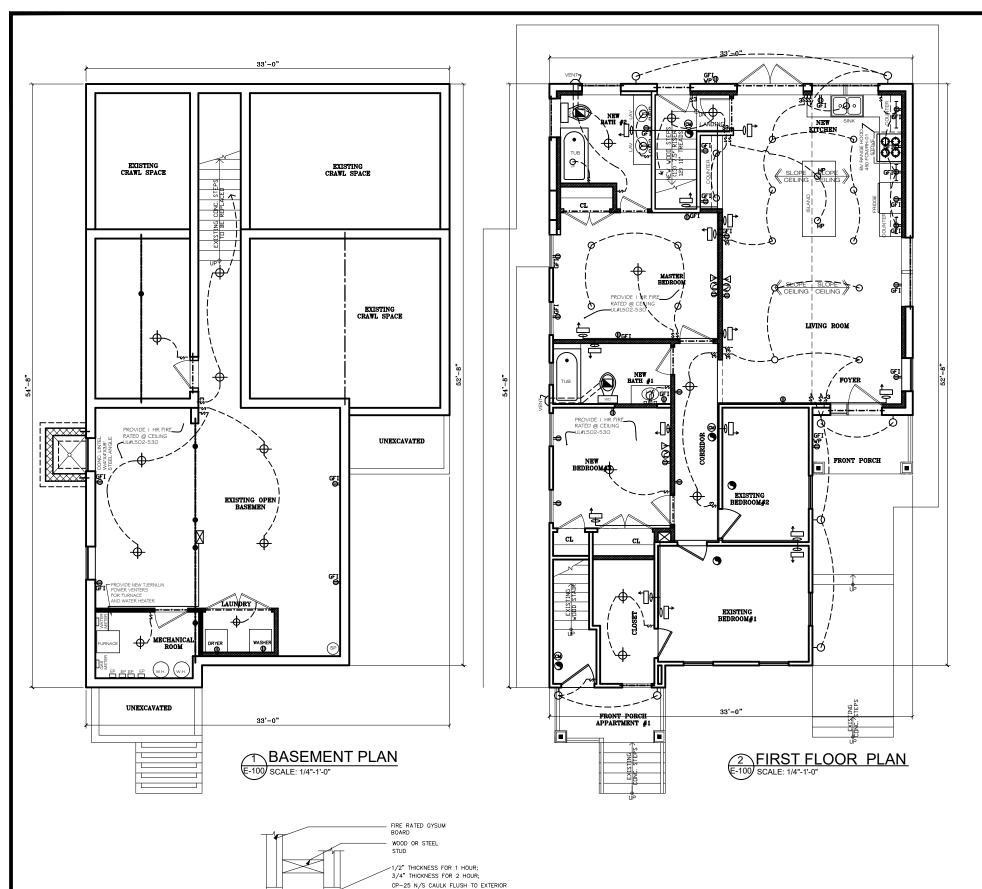

PANEL OF FIRE RATED WALL BOARD. MAXIMUM ANNULAR SPACE TO BE FILLED

IS 2 1/2". METAL PIPE.

3 FIRESTOP OF PENETRATIONS

OR METAL CONDUIT

DAMMING MATERIAL: NON-COMBUSTIBLE

E-100 N.T.S.

MINERAL WOOL OR FIBERGLASS

INSULATION

ELECTRICAL NOTES

- ALL ELECTRICAL WORK TO BE INSTALLED ACCORDING TO REQUIREMENTS OF STATE AND LOCAL AUTHORITIES, PUBLIC SERVICE ELECTRIC AND GAS CO., AND THE CURRENT EDITION OF THE NATIONAL ELECTRIC CODE.
- 2. CONTRACTOR SHALL VERIFY ON SITE ALL CONDITIONS AND MEASUREMENTS SHOWN ON THE DRAWINGS.
- 3. ALL WIRING TO BE COPPER #12 MINIMUM THHN. PROVIDE CONDUITS AS REQUIRED BY CODE. ALL WIRING WITHIN BUILDING SHALL BE INSTALLED IN EMT 3/4" MINIMUM. WIRING GREATER THAN #12 TO BE TYPE RHW.
- 4. PROVIDE GFI RECEPTACLES IN TOILETS.
- 5. PROVIDE HIGH AND LOW VOLTAGE (CONTROL) WIRING, DISCONNECT SWITCHES, TIME CLOCKS, ETC. FOR HVAC UNITS. PROVIDE ALL RELATED TEMPERATURE CONTROLS AND WIRING.
- 6. ALL CURCUIT BREAKERS SHALL HAVE A MINIMUM A.I.C. RATING OF 10,000 RMS SYMMETRICAL AMPHERES. THE USE OF TANDEM OR DUPLEX BREAKERS IS NOT ACCEPTABLE.
- 7. PROVIDE LUMINAIRIES AS SCHEDULED, COMPLETE WITH LAMPS. ALL FLUORESCENT LAMPS TO BE OF THE LOW WATTAGE ENERGY SAVING TYPE 180 WATT HIGH OUTPUT MAIN IN BASEMENT. PROVIDE 400 WATT H.P.S. LIGHTING IN HIGH BAY AREAS.
- B. DUPLEX RECEPTACLES TO BE RATED AT 15 AMPS, 125 V HUBBELL #5262 OR EQUIVALENT. SINGLE POLE SWITCHES TO BE LEWITON #1101, 15 AMPS, 125 V. CONTRACTOR TO PROVIDE WALL PLATES. OWNER TO SELECT COLOR AND FINISH. 8 DUPLEX OUTLETS MAXIMUM PER CIRCUIT.
- 9. COORDINATE ALL WORK WITH OTHER TRADES.
- 10. CIRCUITS MAY BE GROUPED IN A SINGLE CONDUIT AT CONTRACTORS OPTION IN ACCORDANCE WITH THE N.E.C. CONCERNING MAXIMUM NUMBER OF CONDUCTORS IN TRADE SIZES OF CONDUIT OR TUBING. PROVIDE NEUTRAL PER
- 11. PROVIDE EMERGENCY LIGHT, WRING, AND EXIT LIGHTS AS SHOWN.
- 12. THE INSTALLATION OF FIXTURES SHALL BE IN ACCORDANCE WITH FIXTURES MOUNTING DETAILS AS SHOWN ON THE DRAWINGS. WHEEVER THE INSTALLATION OF LIGHTING FIXTURES AS SHOWN IS IMPRACTICAL, THE CONTRACTOR SHALL INSTALL THE FIXTURES AT NEW LOCATIONS AS DIRECTED BY THE ARCHITECT/ OWNER.

- 13. ALL CONDUITS SHALL BE IN ACCORDANCE WITH THE N.E.C. CODE BUT NOT LESS THAN 3/4" WHEN EXPOSED AND 1" WHEN CONCEALED, WHERE FIXINGES ARE SUPPORTED FROM CONDUIT THE MINIMUM SIZE OF CONDUIT SHALL BE 1" UNLESS OF THERWISE INDICATED.
- 14. SWITCHES FOR CONTROLLING THE LIGHTS SHALL BE MOUNTED 4'-2" ABOVE FINISHED FLOOR AND LOCATED NEAR STRIKE PLATE OF DOOR REGARDLESS OF SWITCH POSITION SHOWN ON DRAWINGS.
- 15. ALL CONDUITS SHALL BE GALVANIZED RIGID STEEL, UNLESS OTHERWISE NOTED.
- 16. SPACING OF CONDUIT SUPPORTS SHALL NOT EXCEED THE MAXIMUM SPACING BAY THE N.E.C., UNLESS OTHERWISE
- 17. COORDINATE WITH OTHER TRADES AND INSTALL CONDUITS AND BOXES TO CLEAR PIPING, DUCTS, OPENINGS, ETC.
- 18. PULL BOXES SHALL BE SIZED IN ACCORDANCE WITH THE N.E.C., UNLESS OTHERWISE INDICATED.
- 19. ALL CONDUITS AND RACEWAYS SHALL BE ELECTRICALLY CONTINOUS AND GROUNDED.
- 20. ALL OUTLETS, JUNCTIONS AND PULL BOXES, SHALL BE PROVIDED WITH COVERS.
- 21. ALL EXPOSED CONDUITS SHALL BE RUN PARALLEL TO BUILDING LINES.
- 22. MINIMUM CONDUCTOR SIZE SHALL BE #12 AWG, UNLESS OTHERWISE INDICATED ON THE DRAWINGS.
- 23. WHERE CONDUIT TERMINATES TO A JUNCTION BOX, PULL BOX, CABINET, CONTROLLER, STARTER, DISCONNECT SWITCH OR PANELBOARD ENCLOSURE, IT SHALL BE PROVIDED WITH DOUBLE LOCK NUTS AND AN INSULATED GROUND BUSHING WITH A COPPER GROUND WHE. THE GROUND WISE SHALL BE BONDED TO THE CONDUIT AND TO THE EQUIPTMENT ENCLOSURES. THE GROUND WIRE SHALL BE AND THE GROUND WIRE SHALL BE AS FOLLOWS:
- A. LIGHTING CIRCUIT: NO. 12 AWG.
 B. POWER CIRCUIT: NO. 12 AWG OR AS PERMITTED BY CODE, WHICHEVER IS HIGHER.

	ELECTRICAL SC	HE	DULE	
SYMBOL	DESCRIPTION		REMARKS	
Ф	DUPLEX OUTLET / 20a / 110v			
GFI ⊕	GROUND FAULT CIRCUIT INT.	20 A	MP. SEP. CIRC. @ 6" ABOVE BACKSPLASH	
•	SWITCHABLE DUPLEX OUTLET			
wp ⇔	WATERPROOF DUPLEX OUTLET			
\$	SINGLE TOGGLE SWITCH 20a /120v			
\$3	THREE-WAY TOGGLE SWITCH 20a /12	0v		
¤	LIGHT FIXTURE / RECESSED			
Ø	INCANDESCENT LIGHT FIXTURE			
Ŷ	LIGHT FIXTURE /EXTERIOR WALL MOUNTED			
4	LIGHT FIXTURE / WALL MOUNTED			
9	LIGHT FIXTURE / WALL MOUNTED			
	ELECTRIC EXHAUST FAN		80 CFM / VENT TO EXTR. W/ 3" ~ DUCT	
SD	SMOKE DETECTOR		110v W/ BATTERY BACKUP / INTRCNCTD	
EP	ELECTRICAL PANEL			
∇	TELEPHONE JACK			
0	TV OULET			
•	HEAT DETECTOR			
®	CARBON MONOXIDE DETECTOR			




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MARTHA BR	AZOBA	N- A	rchited	t Al
570 North Broa Elizabeth, NJ 0 Phone: (908) 3 Fax: (908) 7	7208		15	
https://www.mbar martha@mbarchi				
M.B. Architectur				ing, L
NJ LICENSE/CEF	TIFICATE	#21A	C00109	9200
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PROJECT	Γ			

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PROPOSED CONVERSION/RESTORATION A EXISTING THREE FAMILY HOUS
OWNER/CLIENT
ODETE MENDEZ
PROJECT LOCATION
609 FIFTH AVE BRADLEY BEACH, N.J. BLOCK:57 LOT:9

DRAWING TI	TLE
ELECTRIC FLOOR PL	AL / HVAC LANS
DRAWN BY:	2.2.
CHECKED BY:	M.B.
SCALE:	AS NOTED
DATE:	1-31-2022

DWG NO:	SHEET NO:	
E-100	9 OF 12	

PROJECT NO: MBSS 22-00

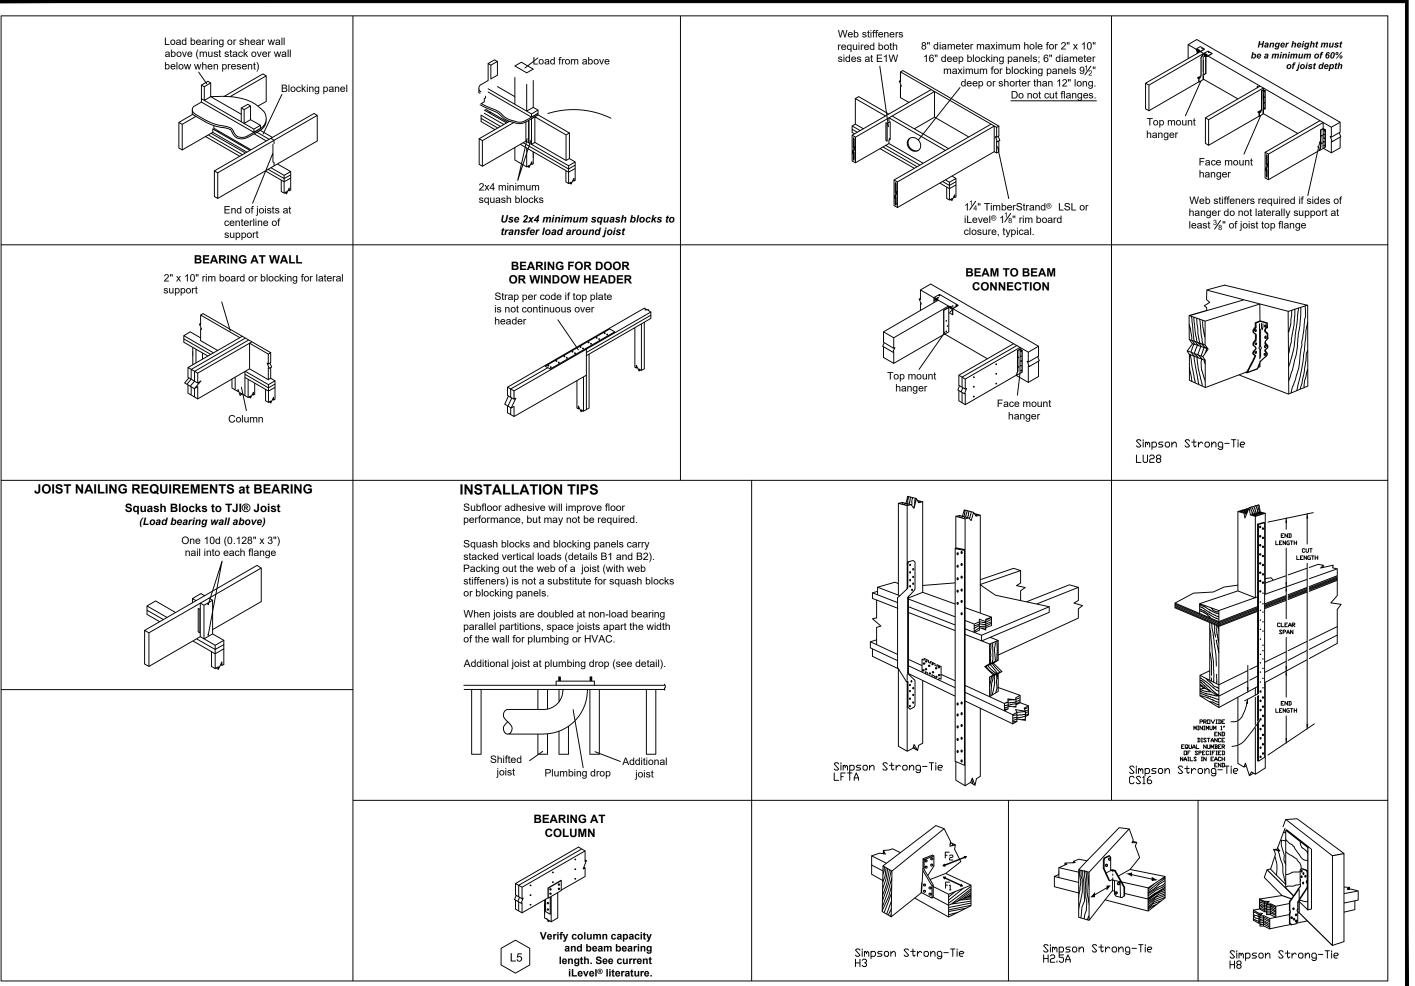



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PROJECT
PROPOSED CONVERSION/RESTORATION AT EXISTING THREE FAMILY HOUS
OWNER/CLIENT
ODETE MENDEZ
PROJECT LOCATION

609 FIFTH AVE BRADLEY BEACH, N.J. BLOCK: 57 LOT: 9


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STRUCTURAL DETAILS	
DRAWN BY:	2.2.
CHECKED BY:	M.B.
SCALE:	AS NOTED
DATE:	1-31-2022

DWG NO:	SHEET NO:
S-100	10 OF 12

PROJECT NO:MBSS 22-00

DIVISION 1-GENERAL DATA DIVISION 2-SITE WORK 02050 DEMOLITION 05520 HANDRAILS AND RAILINGS 01010 SUMMARY OF THE WORK The General Contractor is responsible for the removal of those parts of the existing structure as required, to facilitate installation of the intended inprovements as well as grade walks, etc. Guardrails shall be installed in locations indicated on the drawings. Finish height of guardrail shall be 36' above the balcony. Balusters shall be installed at 4' D.C. spacing. Where no specific design is detailed, provide material allowance of \$50.00 per lineal foot(Design,finish,type to follow) It shall be the General Contractor's responsibility to provide all labor, material, equipment and services for the complete erection, fabrication, installation, testing and proper operation of the project as described in the contract documents or reasonably implied by same. Removal of all debris and refuse from the site and dispose in accordance with applicable regulations. Disserve any and all recycling ordinances. Unless otherwise noted, all metal components shall be fully welded, shop primed and finished with black alkyd paint. Provide all labor and material that may not be specifically indicated but is otherwise required to complete the installations indicated or reasonably implied. The General Contractor shall provide all shoring, sheet piling and bracing as required to retain earthwork and/or temporary support to the existing structure or construction in progress until the completed structural system, as designed, is permanently in place. DIVISION 6-WOOD AND PLASTICS 2. See section 01050 Field Engineering. 01015 SUMMARY OF DRAWING AND CONTRACT INTERPRETATION 06060 LIGHT GAUGE METAL FASTENERS The General Contractor shall be responsible for the verification of all dimensions in the field and shall be responsible for the same in the event of a discrepancy or conflict with the contract documents. The General Contractor shall notify the Architect immediately of any discrepancy before 02100 SITE CLEARING The General Contractor shall be responsible for clearing the site as required for the work as designed. Unless otherwise noted, all trees that are indicated for removal shall include the complete removal of stumps. All plant naterials that are cleared for construction shall be taken from the site and disposed of lawfully. Topsall shall be cleared, stockpiled and protected from erosion. The remaining site shall likewise be protected against excessive erosion as required by actual site conditions or the authority having jurisdiction. See Section 01050 Field Engineering. Where indicated on the drawings, provide temporary snow fencing around the trees and plants and not allow vehicles, equipment or construction materials to be parked/stored in these areas. Provide all fasteners, metal hangers and connectors required for the intended installation. Any fasteners exposed to the exterior or in direct contact with pressure treated lumber shall be hot dipped galvanized or stainless steel. commencing work. All work shall be completed in accordance with the contract documents. No deviation, omission or addition permitted without prior written approval or prior authorization of the Architect. All questions and directions shall be addressed to the Architect if the project observation is part of the Architect's scope of work. Reference standard shall be the National Forest Products Association Design Specification for Wood Construction (actest edition) and the American Institute of Timber Construction Manual (latest edition). Large-scale drawings shall supplant smaller scale drawings. Unless otherwise noted, details drawn of a particular assembly are intended to represent similiar conditions throughout the project. 02720 STORM WATER DRAINAGE Any below grade storm water piping shall be SDR 35 PVC with sizes as indicated on the drawings. Pitch the pipes in accordance with the requirements of the National Standard Plumbing Code. All below grade piping shall be adequately supported by the sub-grade before backfilling. Wherever possible, piping shall be placed far enough below grade to prevent damage by future landscape work. Provide leader shoe and cleanout at all downspout connections. Where areaways are indicated on the drawings, provide a bronze or cast iron floor drain with removable slotted cover. Bottom of drain box shall contain space for the accumulation of sediment. See drawings for location of outfalls from below grade drainage systen. Whenever possible, the General Contractor shall coordinate the layout of structural Traning with the location of built-in electrical fixtures indicated in the drawings. It is intended that the location of these fixtures take precedence over the location of structural Franing, "Plumber's boxes' may be used in certain locations only with prior approval of the Architect. Do not scale drawings for dimensions Unless otherwise noted, dimensions are given from stud face to stud face or block face to block face. Details for dimensional lumber framing including but not limited to nailing, blocking, bridging and fire stopping shall conform to the referenced standards given. Unless otherwise noted, bridging shall be installed at a maximum of 8°-0' on center and shall be coordinated with mechanical work by other trades. Solid wood 'catting' shall be installed at mid-height in stud walls greater than 8'-0' in height. 01040 PROJECT COORDINATION Where downspouts are discharged directly on grade, provide pre-cast concrete splash blocks. Grade shall slope away from all structures. General Contractor shall coordinate the installation of all subcontracted work including that contracted separately by the Owner. Such work may include but not be limited to security system, telephone, carpeting, cabinetwork and landscaping. DIVISION 3-CONCRETE Framing lumber shall be comprised of the following grade and species for the specified use. All lumber shall be grade stamped by a recognized grading agency, surfaced dry all lumber in contact with masonry shall be pressure treated. 01050 FIELD ENGINEERING 03310 CONCRETE WORK Reference standard shall be American Concrete Institute (A.C.I.) 318 (latest edition). General Contracting shall provide any field engineering services required for the completion of this project. Such work shall include but not be limited to layout of new construction or additions, benchmark elevations, lines and levels. * Studs and plates: Douglas Fir/ Larch stud grade. General Contractor shall provide a 3' concrete mud-sill in the bottom of all footings where concrete is not placed immediately after approval of excavation by the authority having jurisdiction. st Stringers and beams: Douglas Fir/Larch select structural. st Wood blocking: Douglas Fir/Larch or Pine construction grade. Verify if the authority having jurisdiction requires additional field engineering and provide it. The General Contractor shall provide copies of all documentation of it to the Dimer and the Architect if project observation is part of the Architect's scope of work. Such documentation may include but not be limited to foundation survey and location plan, grading plan and soil conservation measures if not included as part of the contract documents. Unless otherwise noted, all concrete shall be 3,500-psi ultimate compressive strength at 28 days and nade with normal weight stone aggregate. Footir shall be formed as conditions require or as indicated on the drawings. * Pressure treated lumber: Suitable for contact with the ground (.40 pcf). Plywood shall be grade stamped by the American Plywood Association for the required span. It shall be made with exterior glue and in the following thickness for the specified use: All grout shall be non-shrinking type with a minimum compressive strenght $\square F$ 4,500 psi. Reinforcing steel shall be deformed bars of new material conforming to American Society of Testing Materials (A.S.T.M.) A615, Grade 60. The size and spacing of bars shall be as indicated on the drawings. Provide chairs or similiar means to locate reinforcing. Unless otherwise noted, concrete coverage of reinforcing steel shall be 3°. The General Contractor shall provide any structural calculations and design associated with shoring, bracing or formwork. Such work is specifically excluded from the contract documents and is part of the General Contractor's means and methods of construction. * Floors other than attic: 3/4' T&G 'sturdi-floor' glued with B.F. Goodrich PL400 or equal and fastened with ring shank nails. Welded wire fabric shall conform to A.S.T.M. A185 with a minimum tensile strengh $\ensuremath{\mathsf{IF}}\xspace$ 170,000 psi. Provide the minimum temperature reinforcing required by A.C.I. $318\ \text{in}$ all concrete slabs where no specific reinforcing is indicated. $\mbox{*}$ Sheathing below fiberglass deck underlayment: 3/4' T&G 'sturdi-floor', see Section 07535 Fiberglass Membrane. The contract documents were prepared in accordance with the Uniform Construction Code of the State of New Jersey. The General Contractor shall conform to this code and other applicable local, county, state and federal * Curved surfaces: two layers 1/4" bendable CDX. DIVISION 4-MASONRY regulations. regulations. The building sub-code to be referenced for this project is I.R.C. 1996 including all amendments contained within the Uniform Construction Code. The General Contractor shall apply and pay for all permits required by the State of New Jersey and the authority having jurisdiction. The General Contractor shall arrange for and coordinate all required inspections. The General Contractor shall make all contacts and connections with the local utilities and pay all required fees. In addition, the General Contractor shall for all required fees in addition, the General Contractor shall for all required displayed fees. 04210 CONCRETE MASONRY UNIT Wood Π' joists, laminated veneer lumber (LVL), parallel strand lumber (PSL) shall be manufactured by Trus-Joist MacMillan Corporation, in the sizes and grade indicated on the drawings. Unless otherwise noted, 'Paralan' shall be 2.0E ES and 'Microlan' (ML) shall be 1.9E. Reference standards shall be the National Concrete Masonry Assocation (N.C.M.A.) Tek Manual for Concrete Masonry Design and Construction and A.S.T.M. C90 (latest edition). Provide all required metal connectors as manufactured by Simpson Strong Tie Company, Inc. Unless otherwise noted, follow all manufacturer required nailing patterns and recommendations. All products shall be installed in accordance with the details given in the residential products brochure published by Trus-Joist MacMillan. All concrete masonry units shall be load-bearing normal weight crushed stone or gravel aggregate moisture controlled block conforming to A.S.T.M. C90 (latest edition) Type 1, Grade N. Unless otherwise noted, provide "Dur-o-wall" nine gauge horizontal joint reinforcement at 16" on center vertical spacing. 2GRAGNATZ GNA 2NDITINITAT 00010 See each section for additional information. Mortar shall conform to A.S.T.M. C270 of the following types: * Type M-for retaining walls and foundations in contact with the earth. The General Contractor shall coordinate the work of other trades with respect to cutting and drilling structural members, again in strict accordance with manufacturer recommendations. Use an adequate number of skilled workers who are thoroughly trained in the trades required to complete the work contained within the contract documents to a standard of care acceptable to the Dwner and Architect. Where the drawings require that hollow masonry blocks be filled, use mortar or grout with a comprehensive strength DF 4,000 psi in accordance with AS.T.M. C476, and installed in accordance with AS.T.S. 1531 for low lift procedures. 06200 FINISHED CARPENTRY Reference standard shall be Architectural Woodwork Institute (A.W.I.) Quality Standards Illustrated (latest edition). 01300 SUBMITTALS Coordinate masonry work with all trades requiring work to be built in place including but not limited to windows and doors, pipes, conduits and beam seats. Interior trim lumber shall be comprised of the following grade and species for the specified use. All lumber shall have moisture content between 6% and 11% Maintain temperature and humidity conditions during fabrication, storage, installation, and finishing. Acclimate all interior trim lumber and do not install it until temperature and humidity have been stabilized and can be consistently DIVISION 5-METALS 01500 TEMPORARY FACILITIES The General Contractor shall provide temporary utilities including telephone and portable toilet for the duration of the project. 05120 STRUCTURAL STEEL Protect all areas where work is not taking place. Reference standard shall be the American Institute of Steel Construction (A.I.S.C.) Steel Construction Manual (latest edition). * Standing and running trim All painted trim shall be clear poplar or finger Jointed pine. All lumber shall be completely primed on all sides with alkyd primer before installation. 01700 CLEANING 2. Structural steel shall conform to A.S.T.M. specifications for the following type(s): (see : molding schedules for specs, sizes, types) The General Contractor is to maintain the site and building in a reasonably orderly condition and keep it free from accumulation of refuse. The General Contractor shall comply with all local regulations concerning disposal of construction debris and recycling. $\boldsymbol{*}$ A.S.T.M. A36 – including but not limited to lintels, beams, flitch plates and columns (except pipe and tubular columns). 3. See drawings for details and additional requirements. All interior trim assemblies made from flat or rectangular trim including mitered door and window casings in excess of three inches shall be biscuit jointed and glued. Interior trim shall be installed to minimize the number of end joints. All work shall be made wherever possible to minimize shrinkage, visibility and opening of inints. * A.S.T.M. A53 Type S, Grade B - structural pipe Provide progress cleaning in areas (if any) of the project that are to be occupied during construction. * A.S.T.M. A501 - structural tubing. Provide a final cleaning using skilled workers, cleaning materials and procedures, which are compatible with all built-in materials to the satisfaction of the Dwner. The site shall be cleaned of any remaining construction debris with all paved areas and walks broom cleaned. Connections shall be designed to develop the full strength of the member over the required span. Exterior trim shall be comprised of the following grade and species for the specific use. All lumber shall have moisture content of 9% to 13%. Filed connections shall be made with minimum $3/4^{\circ}$ diameter high strength bolts conforming to A.S.T.M. A325 or A490 or welded. st Flat trim boards: exterior grade cedar, or alternate describe in the Anchor bolts shall be hot dipped galvanized or stainless steel conforming to A.S.T.M. A307 standards. Unless otherwise noted, anchor bolts shall be $1/2^{\prime}\times16^{\prime}$ long and spaced at a maximum of $6^{\prime}\text{-}0^{\prime}$ on center with a minimum of two bolts per section of foundation wall. 01730 OPERATION AND MAINTENANCE DATA * All exterior profiles, shapes and sizes shall be to match existing. The General Contractor shall instruct the \square where in the operation of all mechanical equipment that is intended to be owner-operated or adjustable. Shall acquire, maintain and provide the DVNER WITH all manuals, instuctions, service schedules, warranties and product literature for any equipment installed as part of the project. All structural steel shall be shop prined with Themec 10-99 or equal Beams shall be supplied with top and bottom flanges drilled at 2'-0' on center to accept 1/2' diameter bolts for attaching wood plates.



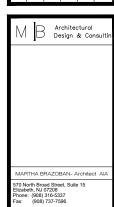

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PROJECT
PROPOSED CONVERSION/RESTORATION AT EXISTING THREE FAMILY HOUSE
OWNER/CLIENT
ODETE MENDEZ
PROJECT LOCATION

DRAWING TITLE	
SPECIFICATIONS	,
DRAWN BY: S.	S.
CHECKED BY: N	I.B.

SCALE:

ATF-

BRADLEY BEACH, N.J. BLOCK: 57 LOT: 9

DWG NO:	SHEET NO:
SP-100	11 OF 12

PROJECT NO:MBSS 22-00

AS NOTED

1-31-202

DIVISION 7-THERMAL AND MOISTURE PROTECTION

07160 DAMP PROOFING

Use Karnak #100 non-fibrated emulsion damp proofing Surfaces shall be free from oil dirt laitance and other substances, which may impede adhesion of damp proofling. Repair all cracks or holes 1/4" in width or less with Karnak #920 or #925 trowel grade emulsion and #31 fiberglass membrane or #3036 Polymat before applying surface coat. Coverage shall be at the rate of three gallons to per 100 square feet. Allow film to cure 48 hours before backfilling. Do not apply when rain is imminent and protect from freezing.

07190 VAPOR BARRIER

Provide 6 mil polyethylene where indicated. All seams shall be lapped a minimum of $1/\!\!\!\!\!\!^{-0.5}$

07200 INSULATION

- Insulating materials shall be comprised of the following for specific use:
 - * 2x4 wood stud walls: R13 fiberglass batt with kraft paper facing installed on the warm side
 - * 2x6 wood stud walls: R19 fiberglass batt with kraft paper facing installed on the warm side
 - * Floor joist over vented or non-vented crawlspace: R22 fiberglass batt un-faced installed
 - * Cathedral ceilings, wood framed: R22 fiberglass batt with kraft paper facing installed on the
 - $\boldsymbol{\ast}$ Attic floor joists, wood framed: R30C or R30 fiberglass batt with kraft paper facing installed on the warm side.

07620 FLASHING AND SHEET METAL

- Reference standard shall be the Architectural Sheet Metal Manual published by the Sheet Metal and Air Conditioning Contractors National Association, Incorporated.
- Flashing materials shall be comprised of the following for the specific use. Where no specific sheet metal gauge is given, provide material that is of the heaviest gauge given in the reference standard for the specified use. Pre-manufactured pieces may be used provided they meet the specific
- * Visible locations including but not limited to chimney flashing, counter-flashing, exposed crickets with low slope and window head cap flashing: 16 ounce lead coated copper
- * Concealed locations: .019" P.V.C. coated aluminum.
- Provide overlap of building paper at all window and door heads. See drawings for additional flashing details.

07920 SEALANTS AND CALLKING

- Throughout the project, provide sealants of the highest quality and those that are compatible with all materials that they are in contact with.
- Unless otherwise noted, provide Sikaflex 15 LM (or Sikaflex 1A for radon work) or equal. When requested by the Architect, provide samples or product literature of any proposed substitutions

DIVISION 8-DOOR AND WINDOWS

08600 EXTERIOR DOORS AND WINDOWS

- Interior doors shall be as indicated on the drawings and as selected by the Contractor/Architect
 - Exterior doors and windows shall be as indicated on the drawings and as selected by the

08710 FINISH HARDWARE

Finish hardware shall be as selected by the Contractor/Architect.

DIVISION 9-FINISHES

09250 GYPSUM DRYWALL

- Reference standard shall be the Gypsum Construction Handbood published by the United States Gypsum
- Company.

 Materials shall be comprised of the following for the specified use. Provide all accessories of the highest quality required where indicated on the drawings or as needed for a complete installation:

 * Interior walls: 1/2" tapered edge.

 * Interior ceilings: 1/2" tapered edge, double layer where so indicated.

 * Interior wall and ceilings of garage: 5/8" Type "//", one hour rated.

 * Bathroom walls and ceilings: 1/2" "green board".

 * Tile backer board: Georgia Pacific 1/2" Dens-Shield Tile Backer.
- Provide a jointing system including reinforcing tape and compound recommended by the wallboard manufacturer. Where gypsum drywall is to be installed over wood framing, it shall be glued and screwed in

09300 CERAMIC AND STONE TILE

- Referenced standard shall be the Handbook for Ceramic Tile Installation published by the Tile Council of
- Provide the following material allowance(s) (Labor and installation materials shall be included in the base

 - oid): * Kitchen floor: \$6.00 per square foot, porcelain tile. * Bathroom floor and baseboard, tub surround including ceilings: \$4.00 per square foot. * Marble saddles: \$45.00 per linear foot (Hollywood bevel).
- See drawings and tile details for specific applications that are referred to in the reference standard.
- Unless otherwise noted, tile shall extend into concealed areas below any built-in furniture without a disruption of the tile pattern.
- Unless otherwise indicated on the drawings, lay tile in a grid pattern

NOON PAINTING

- Interior painting shall be comprised of the following systems for the specified application. For the purpose of bidding, assume one color throughout for walls, ceilings and trim. All paint shall be Benjamin Moore Regal and shall be selected by Iwner from the standard color charts:
 - Walls: Latex system, one coat primer with two coats flat finish.
 Ceilings: Latex system, one coat primer with two coats flat finish.
 - * Wood trim: Alkyd system, one coat primer with two coats semi-plass finish

DIVISION 10-SPECIALTIES

10600 TOILET AND BATHROOM ACCESSORIES

- The General Contractor shall provide solid blocking in all new bathrooms for accessories that will be provided by
- At a minimum, each new bathroom shall include one towel bar, one robe hook and one toilet paper holder

10820 TUB AND SHOWER DOOR AND ENCLOSURES

The General Contractor shall provide a polished crome rod with chrome hooks at each tub/shower combination

10900 CLOSET SPECIALTIES

The General Contractor shall provide white ventilated wire shelving at all coat closets and linen closets, Closet Maid or equal. Coat closets shall be provided with one pole and shelf. The linen closets shall be provided with five shelves.

DIVISION 11-EQUIPMENT

11450 RESIDENTIAL EQUIPMENT

- The building Owner shall provide all appliances. The General Contractor shall provide all mechanical and electrical connections and service to residential appliances including the following:
 - * Refrigerator/freezer
 - * Electric range
 - * Combination Microwave/re-circulating hood.

DIVISION 12-FURNISHINGS

DIVISION 13-SPECIAL CONSTRUCTION

N/A

DIVISION 14-CONVEYING SYSTEMS

N/A

DIVISION 15-MECHANICAL

- The plumbing work required for this project shall be done by a licensed Plumbing Contractor in strict accordance with the Plumbing Sub-code and finally the approval of the authority having jurisdiction. The Architect and Iwner shall rely upon the performance of the Plumbing Contractor to comply with these requirements. Provide all labor, materials, equipment and services for the complete installation, testing and proper operation of the systems specified and shown on the drawings and Plumbing Schedule or reasonably implied.
- . Provide new water supply and sanitary sewer to new residence as required.
- 3. New supply lines for domestic hot and cold water shall be type 'M' copper when used above ground and type 'K' when used below ground. Fittings shall be copper. All hot and cold water lines that run through un-conditioned spaces shall be installed with 1' fibergloss and covered with all service jackets. Provide 2' air chamber at all fixtures. Where air chambers cannot be installed, manufactured air chambers are acceptable. All horizontal supplines shall be pitched upwards in the direction of flow to be completely drained.
- New waste/vent lines shall be Schedule 40 PVC or ABS with following exceptions.
- All waste lines regardless of material shall be insulated for sound with Armaflex jackets and fiberglass batt - And was to impose regardless or material shall be insulated for sound with Armatex jackets and hiperglass but insulation.

 - All horizontal waste/vent lines shall be pitched as required. Where vents pass through the roof, they shall be organized to minimize the amount of roof penetrations. They shall also be installed wherever possible on the 'rear' of the building.

 - Any issues of coordination with respect to the forgoing shall be brought to the attention of the Architect, provided that project observation is part of the scope of work.
- . New internal gas piping shall be black steel pipe conforming to A.S.T.M. A12 with malleable screwed iron fittings. The exterior exposed pipe and fittings shall be galvanized. Provide an internal shut-off for gas grill line and quick disconnect if indicated on the drawing.
- . New hose bilbs, where indicated on drawings, shall be of a fost-proof design. Provide pitch to back of interior of accessible
- The General Contractor shall select select the new fixtures and fittings. He is to take precautions to protect the fixtures stored on-site or installed. When the Plumbing Contractor or General Contractor is responsible for the purchasing of the fixtures or fittings, they shall also be responsible for the timely acquisition and condition of same and replace any damaged or imperfect items or missing parts, at no additional cost to the Owner. Set fixtures level and in proper alignment with respect to walls and floors. Caulk wall, floor and counter-mounted fixtures and fittings to ensure all installations are water-tight.
- B. The General Contractor is to provide all sleeves, flashing boots and similiar items required for passage of piping through walls or floors. Provide all brackets, hangers, isolators and other devices required to install rough plumbing to ensure a structurally sound and silent system with proper operation. Provide cleanouts and volves in required locations and that are accessible. Provide escutcheon plates in finishes to match exposed pipe in areas that are exposed to finished spaces.

15600 HEATING VENTILATION AND AIR CONDITIONING (H.V.A.C.)

- The H.V.A.C. work required for this project shall be done by a licensed Plumbing Contractor and a qualified Mechanical Contractor in strict accordance with the Plumbing Sub-code and other codes and finally the approval of the authority having jurisdiction. The Architect and Dimer shall rely upon the performance of the Plumbing and Mechanical Contractors to comply with these regulations. Provide all labor, materials, equipment and services for complete installation, testing and proper operation of the systems specified or reasonably implied. The system shall meet the following minimum performance criteria:
 - * Heating mode shall maintain an interior temperature DF 170 degrees F with a relative humidity DF 40% when the exterior temperature is 0 degrees F.
 - * Cooling mode shall remain an interior temperature DF 175 degrees F with a relative humidity DF 40% when the exterior temperature is 95 degrees F.
- Without restricting the performance requirements, the scope of work shall consist of the following: * Provide new two zone gas fired forced hot air furnaces with min 12 SEER condensing units.
- For new ductwork, provide galvanized sheet metal fabricated and installed with the requirements of ASJRARE. and SMACINA: standards. Sheet metal ducts shall be wropped with 11/2° of foll face fiberglass insulation. All seams shall be covered with 4' wide insulating tape. All branch take offs shall have volume dampers. Flexible insulated ductwork may be utilized in the attic for run-outs from main trunks to supply or return registers or wall drops. Such runs shall be kept a sshort as possible with smooth transitions and a maximum of 6'd' in length. All flexible ductwork shall be supported with straps specifically designed for this purpose.
- The entire heating system shall be tested at the completion of the project before Dwner occupancy. It shall be established that all controls and units are performing satisfactorily. The system shall be checked for vibration and excessive noise and all such conditions shall be corrected before the issuance of the Certificate of Dccupancy at no additional expense to the

DIVISION 16- ELECTRICAL

16400 GENERAL ELECTRICAL WORK

- The electrical work required for this project shall be done by a licensed Electrical Contractor in strict accordance with the Electrical Sub-code and finally the approval of the authority having jurisdiction. The Architect and Dwner shall rely upon the performance of the Electical Contractor to comply with these regulations.
- * Provide all labor, materials, equipment and services for the complete installation, testing and proper operation of the systems specified and shown on the drawings and Electrical Fixture Schedule, or reasonably implied.
- Without restricting the performance requirements, the scope of work shall consist of the following:
 - * Provide new 2004 simple phase service to residence as required.
- New fixtures and fittings shall be indicated on the Electrical Fixture Schedule and located on the drawings. Take precautions to protect fixtures stored on-site or installed against danage. When the Electrical Contractor or General Contractor are responsible for the purchasing of fixtures, they shall also be responsible for the timely acquisition and condition of same and replace any danaged or imperfect thems or missing parts at no additional cost to the Owner. Set fixtures level and in proper alignment with respect to the walls and floors.
- Before wiring of fixtures and receptacles, the Electrical Contractor shall perform a walk-through with the Dwner (and the Architect, if the project observation is part of his scape of work). The purpose of this will be to review the location of all items in consideration of other work and furniture layouts. Approval of the proposed electrical system layout shall not be construed as a waiver of the General Contractor's responsibilities with respect to the system's performance. All additions or deletions of fixtures shall be processed through a change order.
- Unless otherwise noted, switches shall be of the toggle type. Colors of devices and faceplates may vary from room to room and shall be selected by the Electrical Contractor. The Electrical Contractor shall verify control and options for any ceiling fans before the final connection and closure of the ceilings and walls.
- Provide snoke detectors where indicated on the drawings and in the following locations. All installations shall be in accordance with N.F.P.A. 74. All detectors shall have primary A.C. power source with a battery backup when the primary power source is interrupted. Low voltage systems shall be pernitted. All detectors shall be interconnected so that actuation of one detector and alarn shall actuate all alarns throughout the dwelling:

 In the vicinity of the bedroons.
- all bedrooms. each story of the dwelling, including the basement and attic.



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li	PROJECT
	PROJECT PROPOSED CONVERSION/RESTORATION A EXISTING THREE FAMILY HOUSE
	OWNER/CLIENT
	OWNER/CLIENT ODETE MENDEZ
	PROJECT LOCATION
	609 FIFTH AVE BRADLEY BEACH, N.J. BLOCK: 57 LOT: 9

DRAWING TIT	LE
SPECIFIC <i>E</i>	ATIONS
DRAWN BY:	2.2
CHECKED BY:	M.B
SCALE:	AS NOTED
DATE:	1-31-202

DWG NO:	SHEET NO:
SP-200	12 OF 12

PROJECT NO: MBSS 22-00